




Proposed North Elevation
1:50

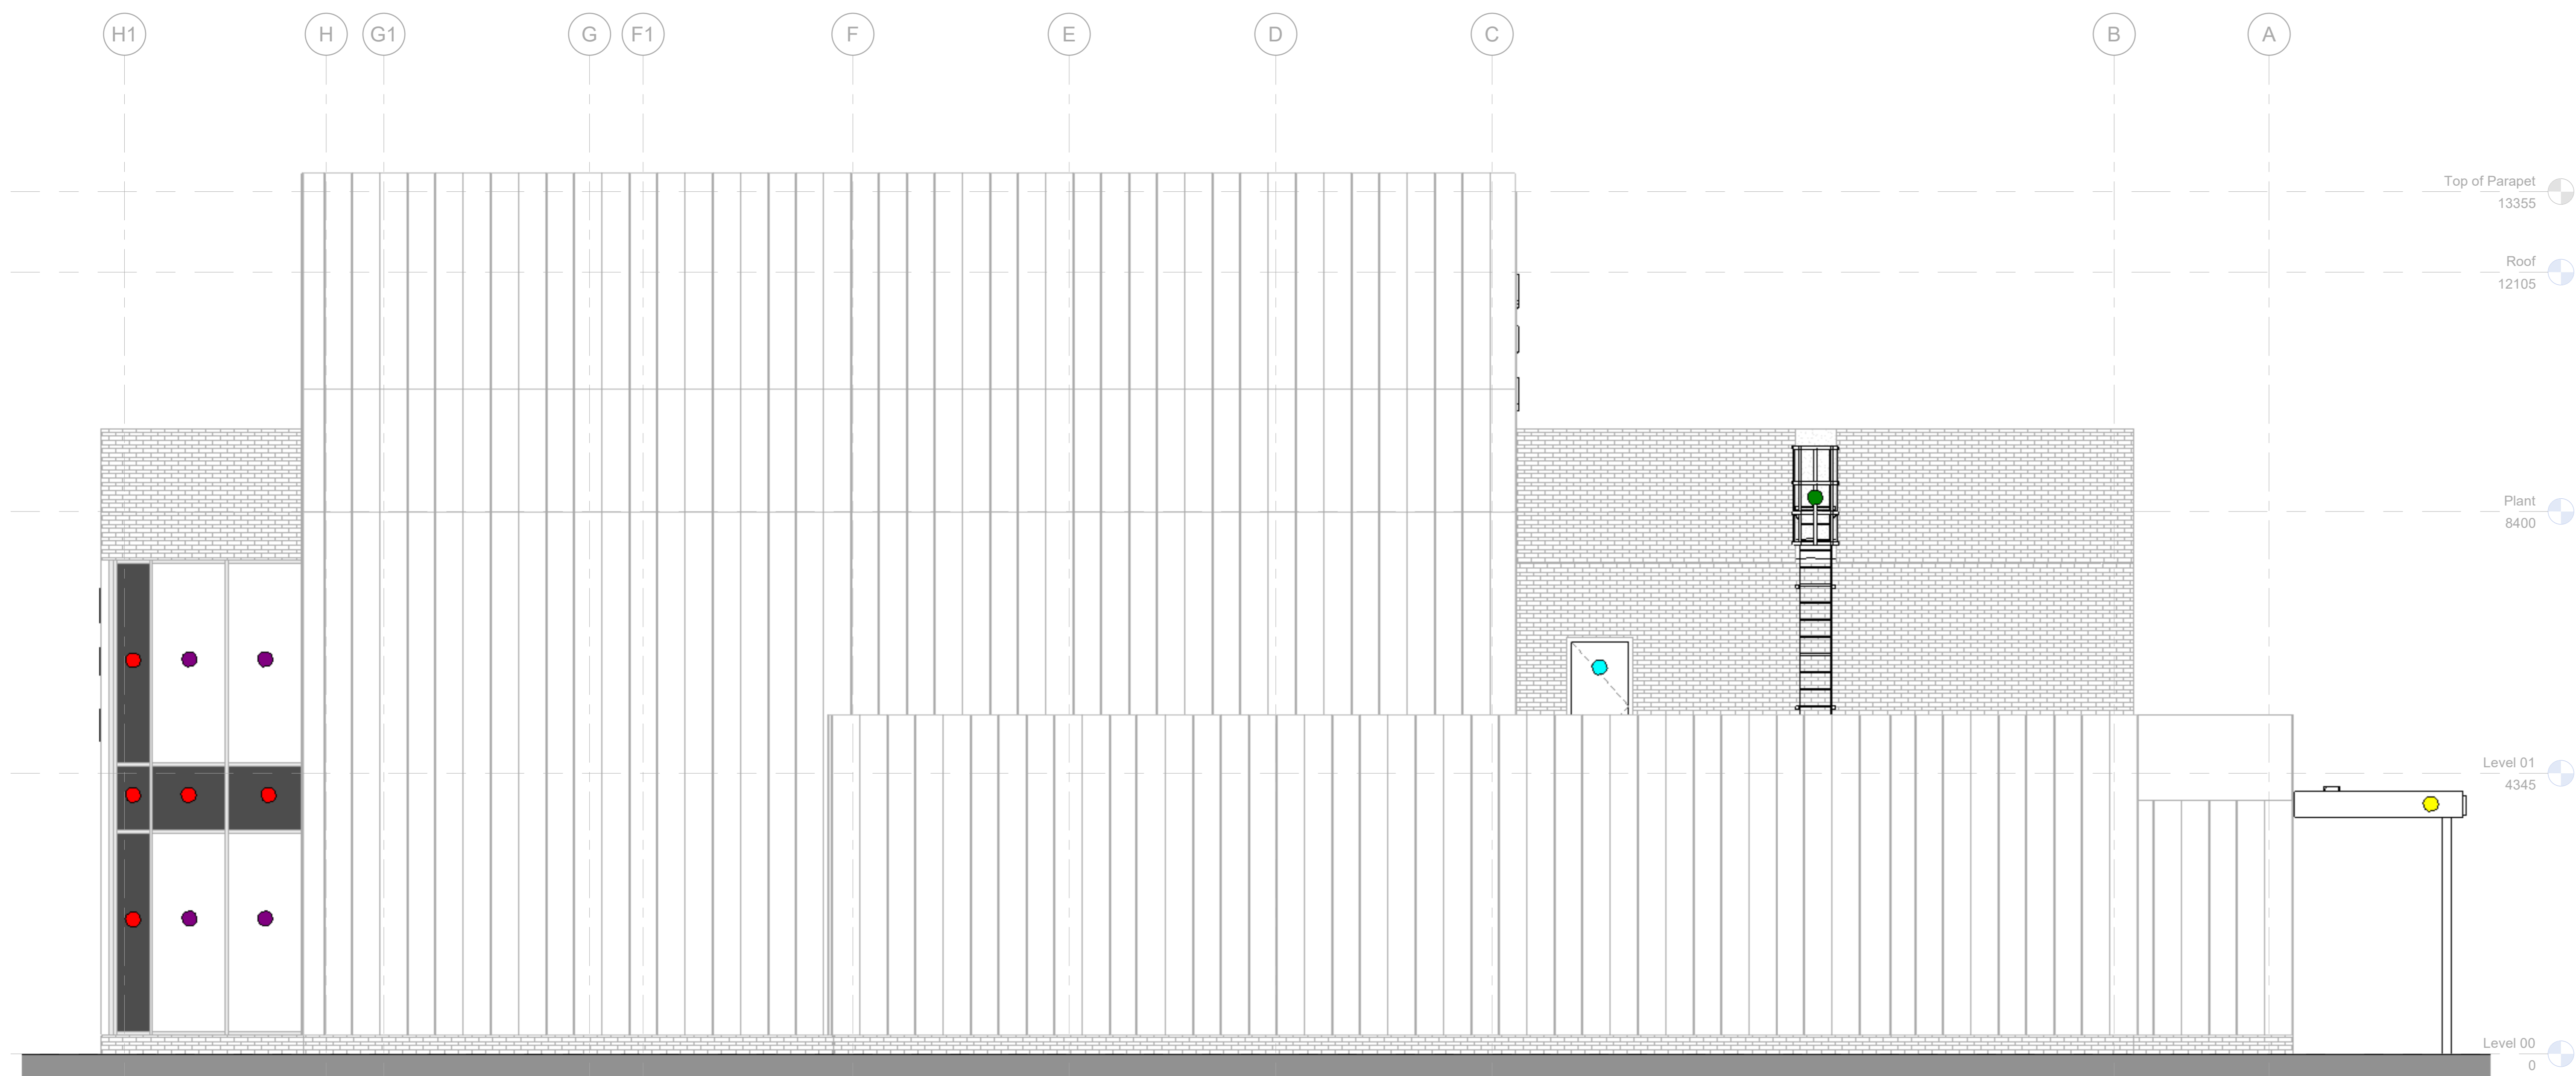

Proposed East Elevation
1:50

Material Key

- Rainscreen Cladding System**
VM Zinc Standing Seam
Colour - Pigmento Brown
U-Value = 0.15 W/m²K
Parapet capping to be VM Zinc. Colour to match cladding
 - Facing Bricks**
Buff (cream multi) brick slips in stretcher bond with mid-brown mortar (bucket handle joints)
215x102.5x65mm
U-Value = 0.15 W/m²K
Parapet capping to be PPC Aluminium. Colour: TBC
 - Brick Plinth to Perimeter of Ground Floor Level**
Buff (cream multi) brick slips in stretcher bond with mid-brown mortar (bucket handle joints)
U-Value = 0.15 W/m²K
 - Glazing with Bronze Frame**
Anodised aluminium-framed double-glazed units
RAL - 8028 to match standing seam cladding
U-Value = 1.20 W/m²K, G-Value = 0.28
 - Spandrel Panels - Feature**
Bronze insulated spandrel panels with Diamond cut anodised aluminium feature panel fixed to the frame.
RAL - 8028 to match standing seam cladding
U-Value = 1.20 W/m²K
 - Spandrel Panels - Solid**
Bronze insulated spandrel panels
RAL - 8028 to match standing seam cladding
U-Value = 1.20 W/m²K
 - Glazed Door with Bronze Frame**
Anodised aluminium-framed double-glazed units
RAL - 8028 to match standing seam cladding
U-Value = 1.20 W/m²K, G-Value = 0.28
 - Canopy**
PPC aluminium profile with integrated seamless gutter profile supported of structural steelwork via 'Z' purlins - Colour: TBC.
PPC aluminium cassette soffit.
(Steel support stubs fixed of structural steelwork to SE's details).
 - Solid PPC Door**
PPC Aluminium-framed double-glazed units
RAL - 8028 to match standing seam cladding
U-Value = 1.20 W/m²K
 - Fixed Access Ladder**
Galv steel CAT ladder with cage and guardrail.
 - Signage**
PPC aluminium lettering to front of canopy
Colour: TBC
 - Louvre**
Triple bank louvre (TBC)
RAL - 8028 to match standing seam cladding
50% free area
- U-values:**
External Walls = 0.15W/m²K
Floor = 0.12 W/m²K
External Glazing = 1.2W/m²K
External doors = 1.4 W/m²K
Roof = 0.12 W/m²K
- G-Value = 0.28**

Drawn By: JC
 Checked By: JC
 Date: 22/07/25
 Scale: 1:50
 Project: 25-1002 - MTX -01-ZZ-DR-A-200100
 Revision: P03
 Client: Betsi Cadwaladr University Health Board
 Project: Royal Alexandra Hospital - SDEC
 Title: Proposed Elevations - Sheet 1
 Date: 13/07/25
 Drawn By: JC
 Checked By: JC
 Date: 22/07/25
 Scale: 1:50
 Project: 25-1002 - MTX -01-ZZ-DR-A-200100
 Revision: P03
 Client: Betsi Cadwaladr University Health Board
 Project: Royal Alexandra Hospital - SDEC
 Title: Proposed Elevations - Sheet 1
 Date: 13/07/25